



564

Dam Details

Crest width	= 3.0 m
Slope Waterside	= 1 : 3
Slope Downstream	= 1 : 3
Wall Length	= 105.1 m
Wall Depth	= 3.5 m
Water Level Depth	= 2.5 m
Freeboard	= 1.0 m
Wingwall Crest Width	= 3.0 m
Slopes	= 1 : 3
Wingwall height	= 1.0 m
Wingwall length	= 30 m
Key trench depth	= 3.0 m (min)
Bottom trench width	= 5.0 m
Top trench width	= 5.0 m
Length of key trench	= 94 m
Central Clay core slopes	= 2 : 1

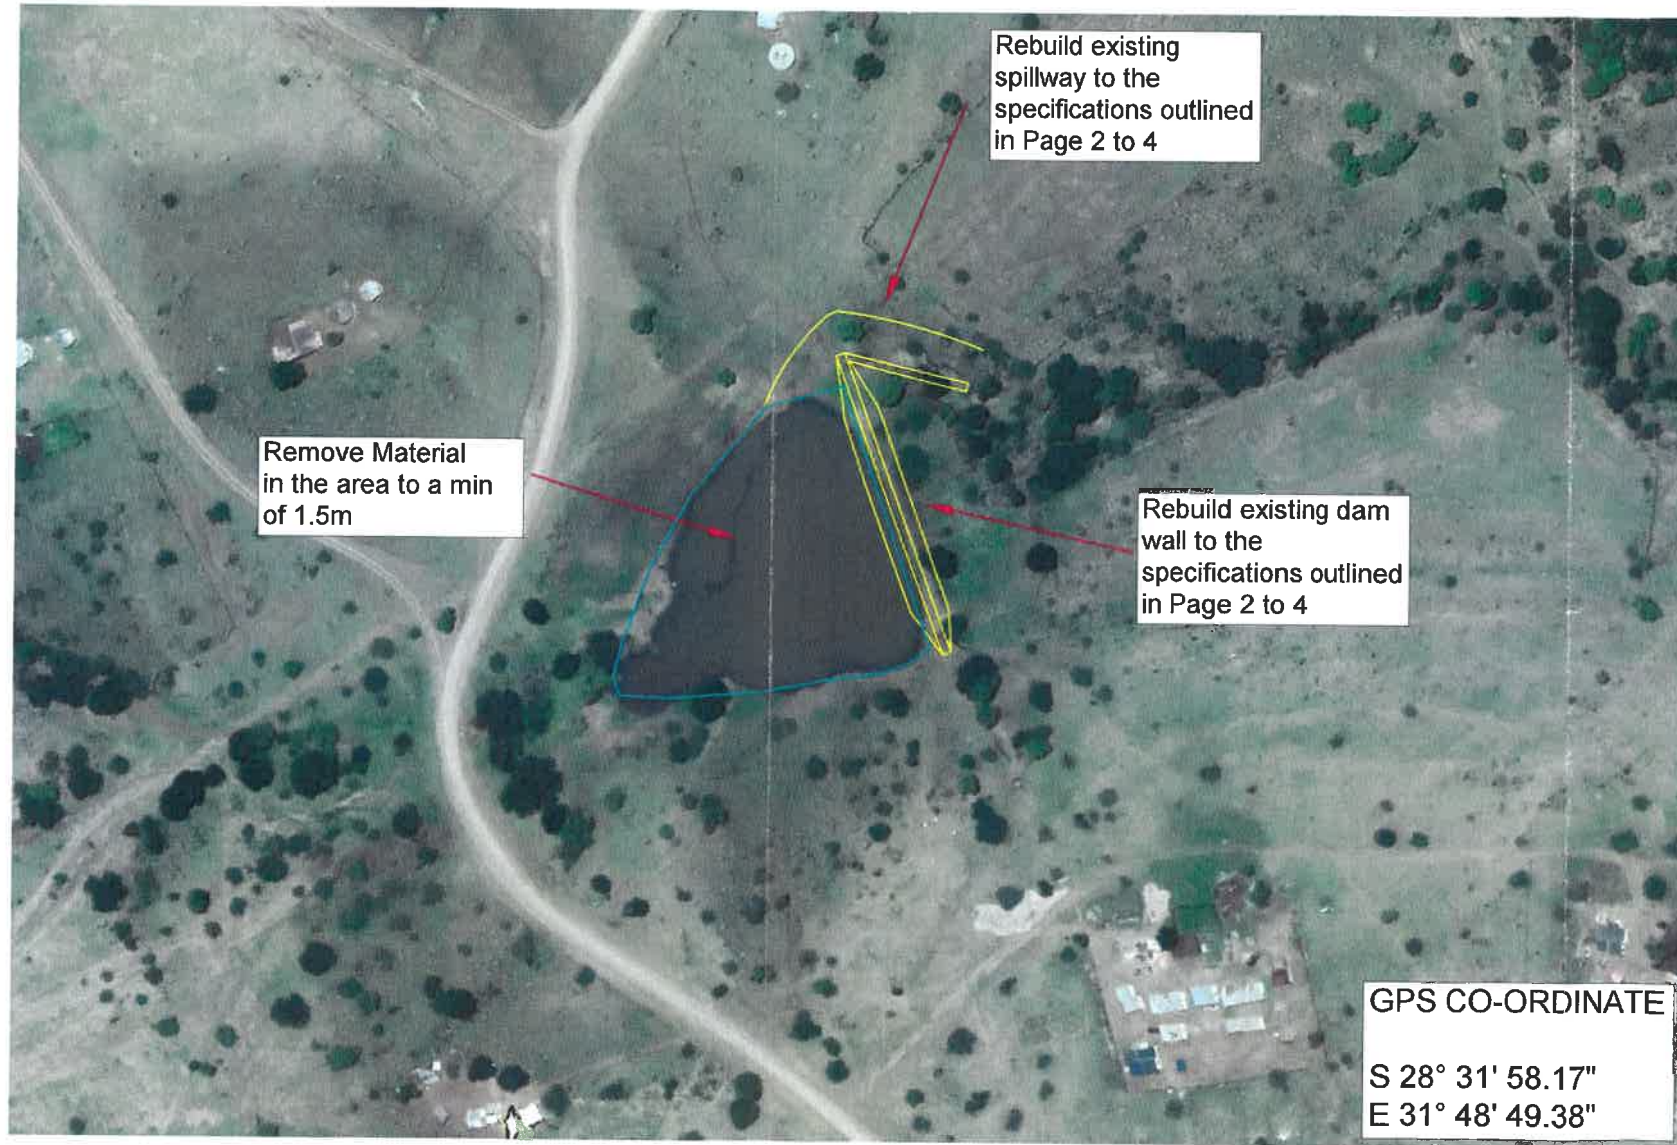

Dam Estimates	
Earth Volume	= 6 966.362 m ³
Storing Capacity	= 10 449.54 m ³
Ratio	= 1 : 1.5

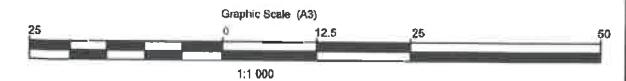

**KZN DEPARTMENT
OF AGRICULTURE &
RURAL DEVELOPMENT**




ENGINEERING SUPPORT SERVICES
CNR HEEREN & VAN RIEBEECK / PRIVATE BAG X 9423
VRYHEID / 3100 / PHONE : 034 - 982 2351
FAX : 034 981 5240


Survey : BC Mhlongo
Design : SD van Greuning
Drawn by : SD van Greuning
Date : 31 May 2018

DRAWING NUMBER:
SDvG/2018/06/DAM-MAG
SCALE (A3) - 1 : 2 500

DRAWING 1 of 4
SOIL CONSERVATION STOCKWATERING DAM
MAGWETSWANA

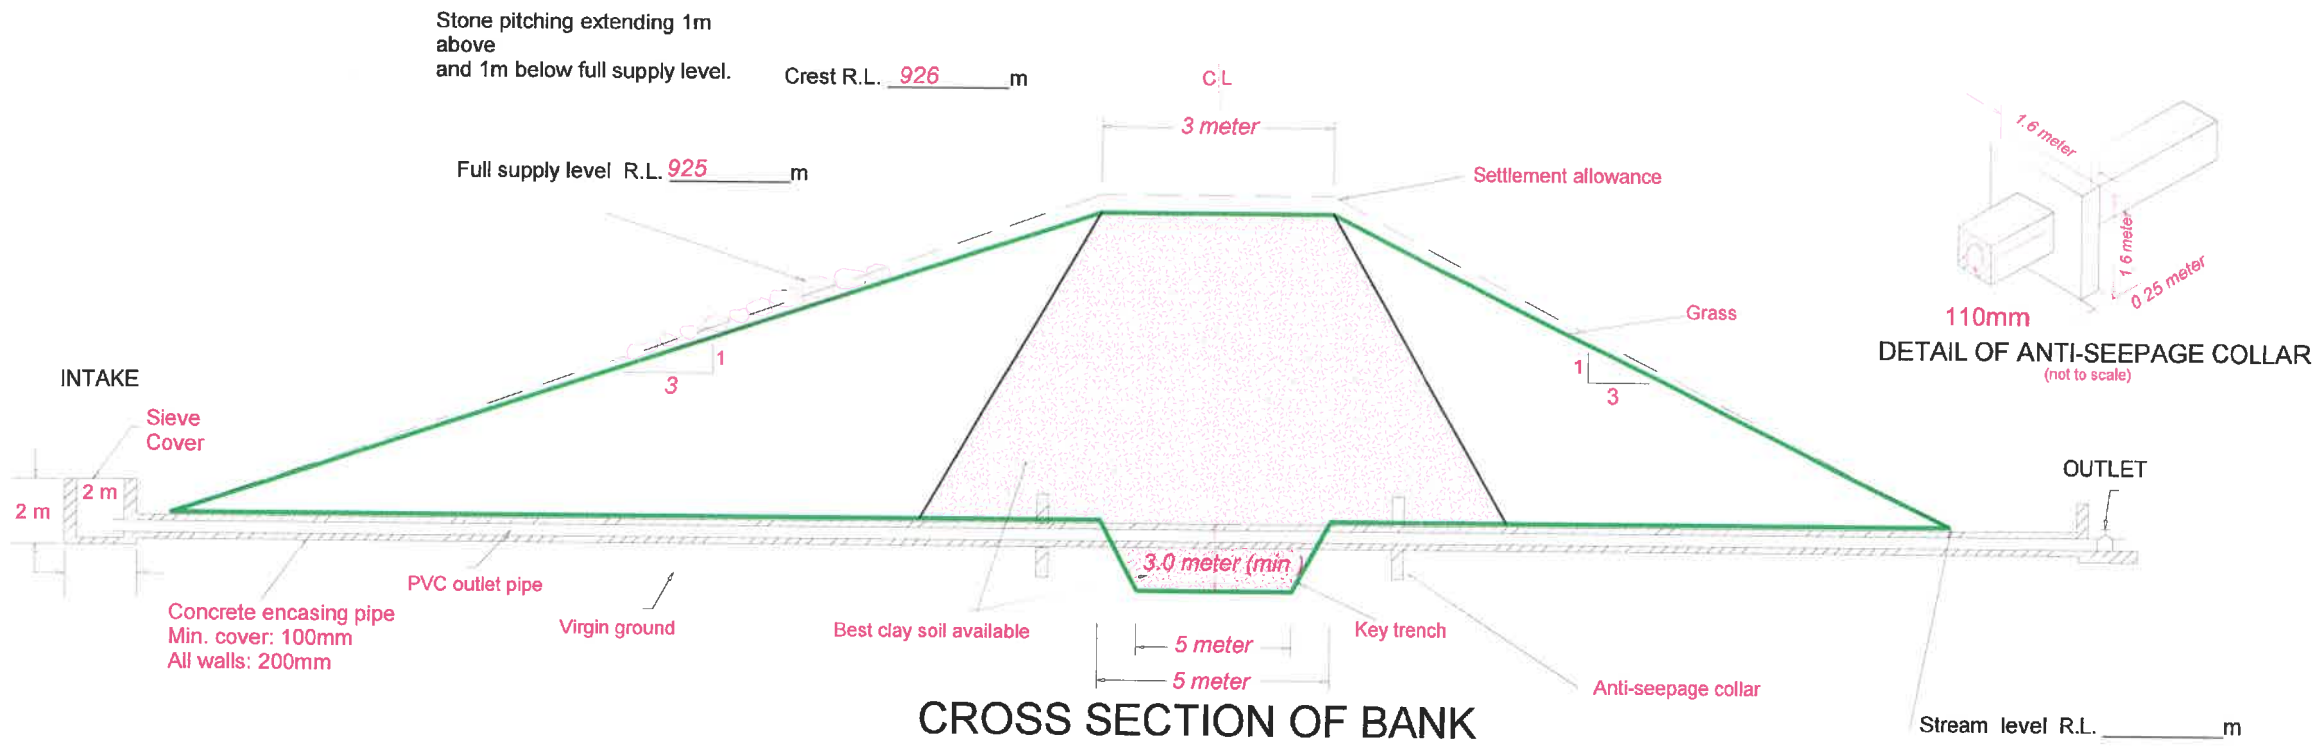

CROSS SECTION OF BANK
(not to scale)

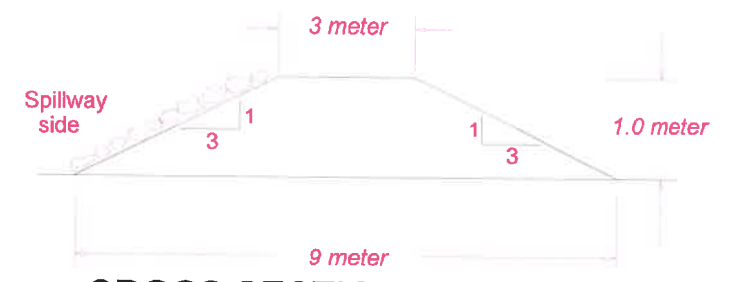

CROSS SECTION OF WINGWALL
(not to scale)

NOTES:

- 1) All organic material and topsoil to be removed from base before construction commences. Stockpile and use for the 10% settlement allowance.
- 2) Soil must be moist to obtain maximum compaction.
- 3) Applicant must call for an intermediate inspection of the site when the:-
 - * Key trench has been dug & before it is filled.
 - * Bank is half completed.
 - * Bank is completed, but before commencing with grassing & stone pitching.
- 4) The whole bank & spillway must be established to a good grass cover on completion. Use : Indigenous Couchgrass.
- 5) Establish common reed (Phragmites) in the stream bed at the dam inlet.
- 6) Concrete mix:- 1 Pocket cement : 110 liter sand : 125 liter stone (20mm stone).

OTHER RELEVANT NOTES :-

Reference drawings	
Page 4	Wall Detail
Page 3	Erodible Soils - Protection Works
Page 1	Layout Plan


Amendment				
No.	Date	Checked By	Description	

* DO NOT SCALE THIS DRAWING - USE FIGURED DIMENSIONS ONLY.
 * ALL DIMENSIONS TO BE CHECKED ON SITE PRIOR TO WORK COMMENCING.
 * ANY DISCREPANCIES ON THE DRAWINGS MUST BE BROUGHT TO THE ATTENTION OF THE ENGINEERS, DESIGN TEAM AND INFRASTRUCTURE MANAGERS AND RECORDED IN THE SITE MINUTES THEREOF.

Surveyed	Drawn	Checked
CNK	SvG	TKO
S.D. van Greuning Designed By :-		31/05/2018 Date
T.K. Onkay Engineers Approval :-		31/05/2018 Date


Project
RE -SCOOPING STOCKWATERING DAM
 Drawing description
PIPE LAYOUT PLAN

Scale	NTS	Date	31/05/2018
Drawing number	SHEET		
SDvG /2018/06/DAM-MAG	2 of 4		

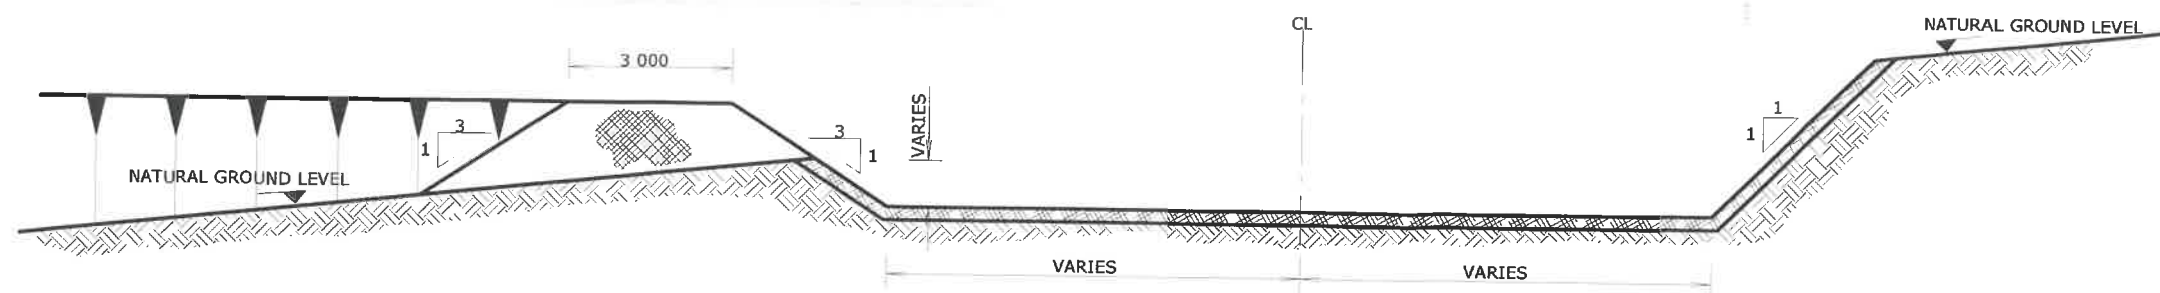


EMBANKMENT & SPILLWAY SECTION A-A


- NOTES :
1. ALL REINFORCEMENT ON THIS DRAWING IS DETAILED IN ACCORDANCE WITH SABS 10400
 2. COVER FOR REINFORCEMENT IS 40mm, UNLESS STATED OTHERWISE.
 3. ALL DIMENSIONS IN MILLIMETER
 4. ELEVATIONS IN METERS
 5. DO NOT SCALE FIGURED DIMENSIONS.
 6. GABION BASKETS TO BE CONSTRUCTED IN ACCORDANCE WITH THE TECHNICAL SPECIFICATION.

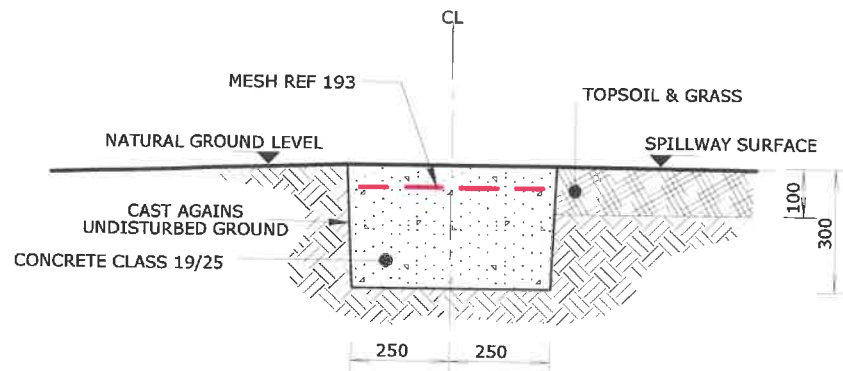


CONCRETE SILL SECTION D-D

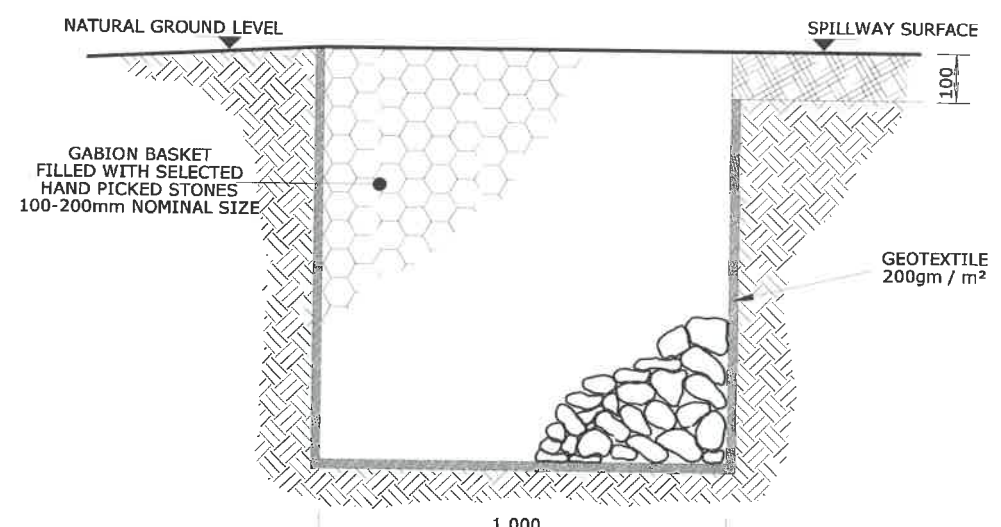

GABION WALL SECTION B-B

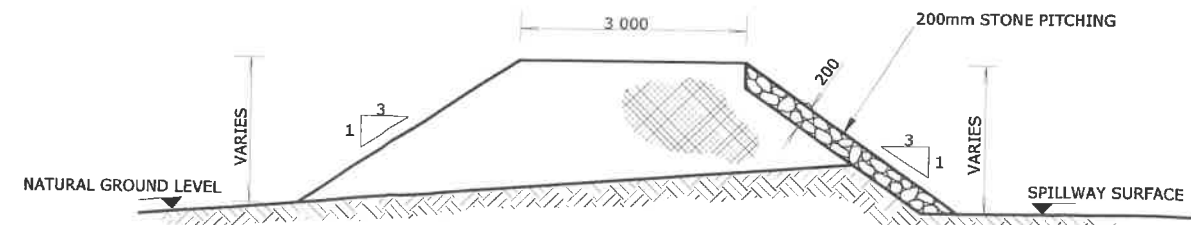

WINGWALL SECTION C-C

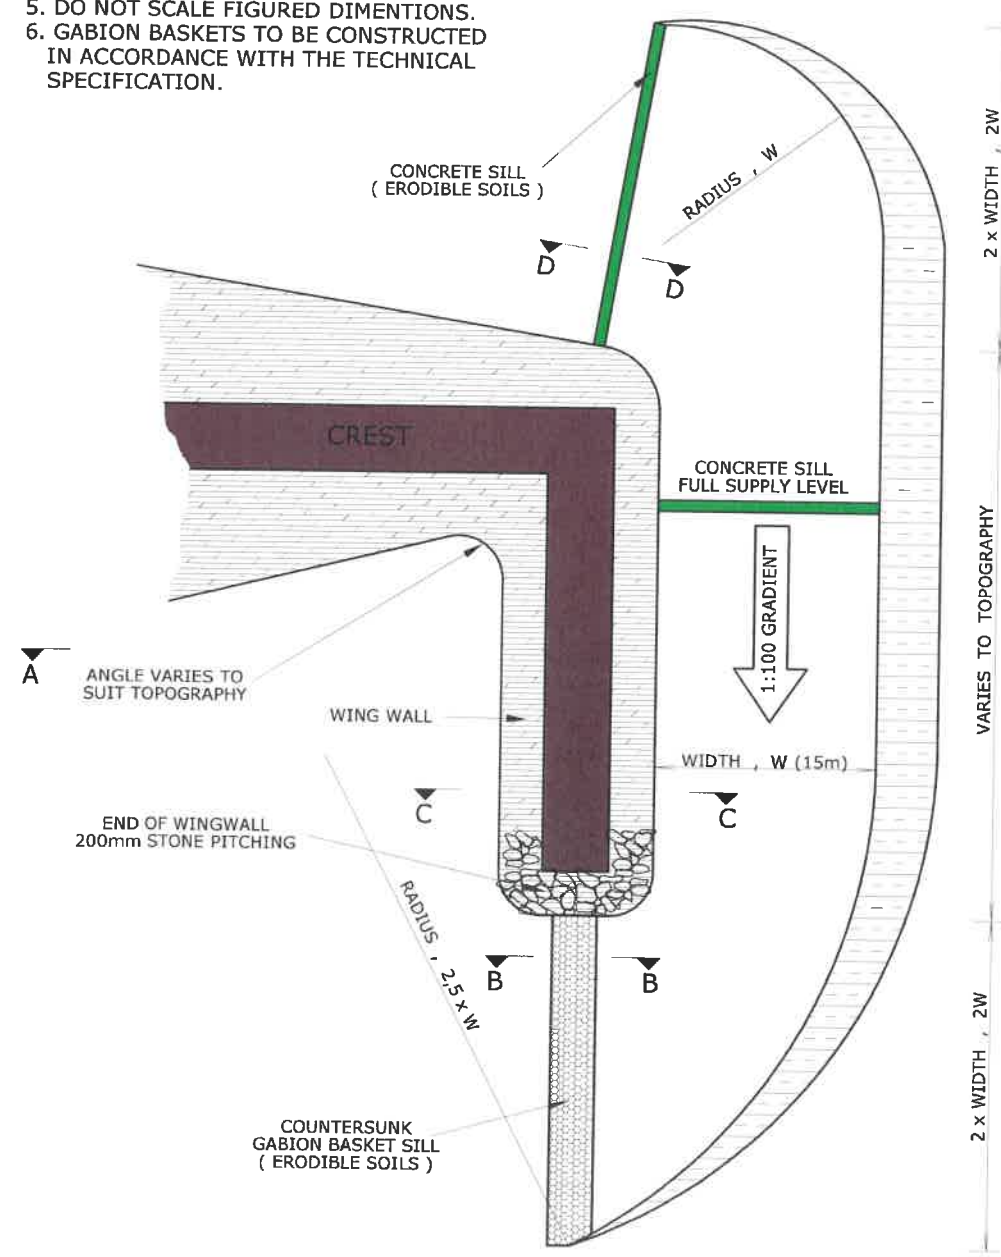

TYPICAL SPILLWAY ARRANGEMENT - PLAN

OTHER RELEVANT NOTES :-

Reference drawings	
Page 4	Typical Wall Detail
Page 1	Layout / Siteplan
Page 2	Pipe plan

Amendment			
No.	Date	Checked By	Description

* DO NOT SCALE THIS DRAWING - USE FIGURED DIMENSIONS ONLY.
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Surveyed	Drawn	Checked
BCM	SvG	TKO

S.D. van Greuning 31/05/2018
 Designed By :- Date

T.K. Onkay 31/05/2018
 Engineers Approval :- Date

Project
RE -SCOOPING STOCKWATERING DAM
 Drawing description

ERODIBLE SOILS - Protection Works

Scale NTS Date 31/05/2018

Drawing number SDvG /2018/06/DAM-MAG SHEET 3 of 4